



2 WTC B6 LEVEL MER PLAN

0 16 32
SCALE IN FEET

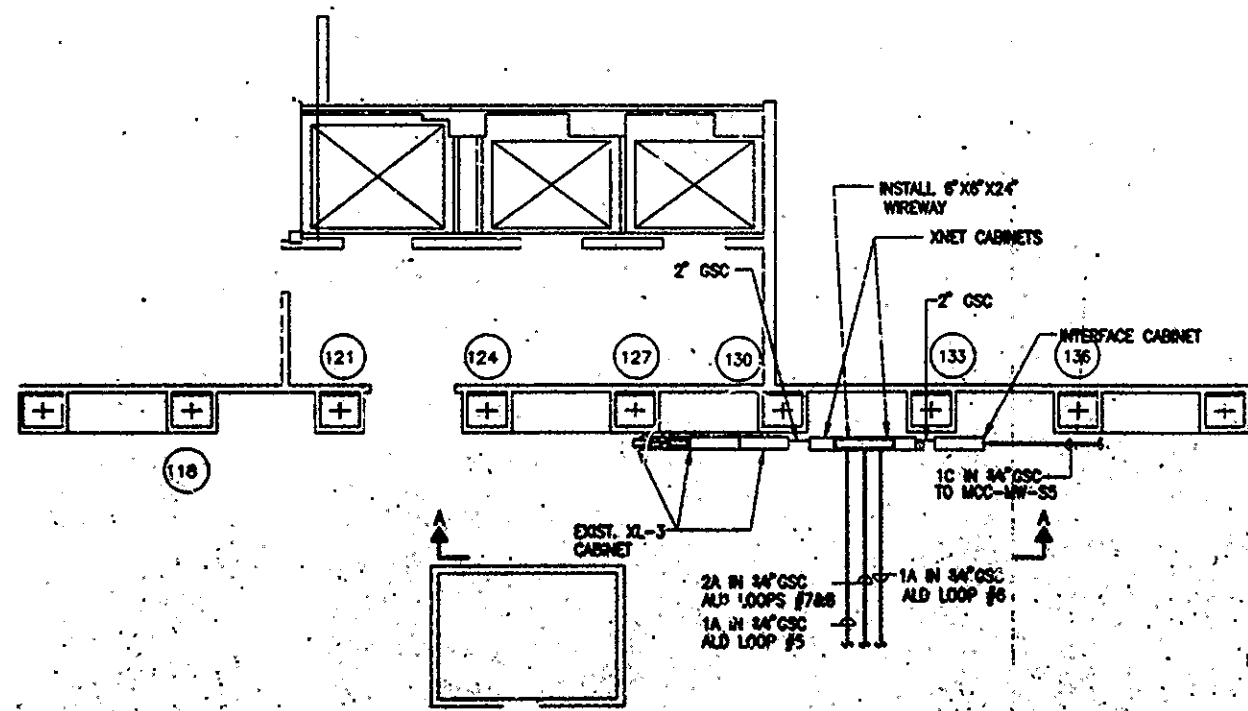

DETAIL 'A'

0 4 8 12 16
SCALE IN FEET

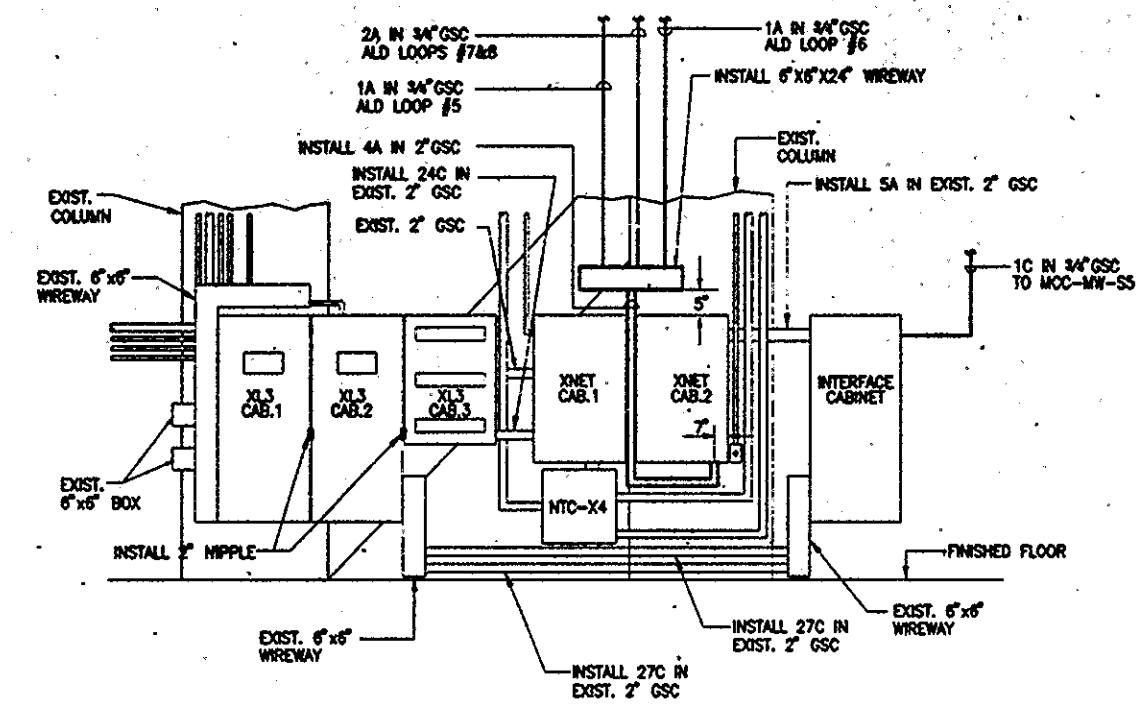


ELEVATION "A-A"
N.T.S.

I HEREBY CERTIFY THAT THIS IS A TRUE AND CORRECT COPY OF ONE OF THE CONTRACT DRAWINGS CONSTITUTING A PART OF CONTRACT NO. 100-84-08 IN THE FORM IN WHICH SAID DRAWINGS EXISTED AT THE TIME THE SAID CONTRACT WAS EXECUTED BY THE PARTIES.

DATE 2/1/00 *[Signature]*
CONTRACT ENGR/ARCH.

DATE 2/1/00 *[Signature]*
ENGINEERING PROGRAM MGR.

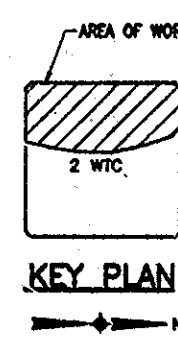

KEY PLAN

NOTES:

1. FOR LEGEND, ABBREVIATIONS & GENERAL NOTES, SEE DWG E-1.
2. FOR B6 LEVEL MER Riser DIAGRAM, SEE DWG E-22.
3. FOR B6 LEVEL MER REMOVAL PLAN, SEE DWG E-24.

Sheet 25 of 58

THE PORT AUTHORITY
OF NY & NJ

[Signature]
CHIEF ELECTRICAL ENGINEER

Engineering Department
Design Division
The World Trade Center

Fire
FIRE ALARM SYSTEM
PHASE II
XLS CONVERSION
ELECTRICAL
2 WTC
B6 LEVEL MER
PLAN

This drawing subject to conditions in contract. All inventions, designs and equipment herein are reserved to Port Authority and may not be used without its written consent.

ROYZMAN
FELDSTEIN
Designed by

ROYZMAN
Drawn by

A.S.
Checked by

Date 5-20-99 Scale AS NOTED

Contract Number Drawing Number

WTC-881082 E-23